
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SACRAMENTO SUBURBAN WATER DISTRICT

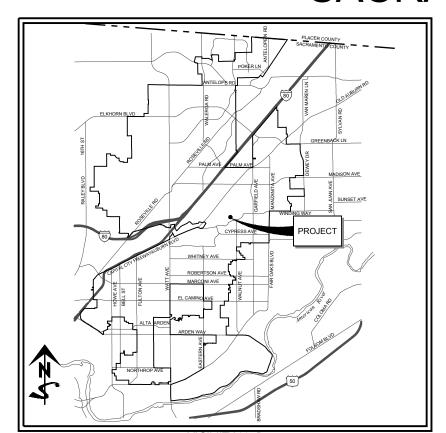

MODIFY PER PROJECT

PROJECT

LOCATION MAP





BID DOCUMENT
PROJECT

JANUARY 2020

MODIFY PER
PROJECT

SAMPLE SET OF PLANS. CUSTOMIZE BASED ON CURRENT PROJECT SPECIFICS

SACRAMENTO METRO FIRE D	ISTRICT
APPROVED AS TO FIRE SERVICE LOCATIONS ONLY. M. DETERMINED BY SACRAMENTO SUBURBAN WATER DIS	
BY:	DATE:
SACRAMENTO SUBURBAN WATE	R DISTRICT
APPROVED FOR CONSTRUCTION OF WATER SYSTEM:	
BY:	DATE:

NOTE: THIS PLAN EXPIRES ONE YEAR FROM APPROVAL

	UTILITY CONTACT INFORMATION	
UTILITY	REPRESENTATIVE	PHONE
GAS	PACIFIC GAS AND ELECTRIC - DON HENDRICKS	916-386-5469
DRAINAGE	SACRAMENTO COUNTY WATER RESOURCES - MARK RAINS	916-874-6851
TELEPHONE	AT&T - DAVE MATEO	916-281-7103
ELECTRICITY	SMUD	916-732-5755
WATER	SSWD - DAVID MORROW / ERIK FLAA	916-972-7171
SEWER	SACRAMENTO AREA SEWER DISTRICT - ROBERT ESPINOZA	916-876-7526
FIRE DISTRICT	SACRAMENTO METROPOLITAN FIRE DISTRICT - #####	916-859-4319
TELEVISION	COMCAST CABLE - JUSTIN WALLACE	650-444-4647
FIBER OPTICS	CCI - GRETCAGN H.	916-879-1029
SURVEY	SACRAMENTO COUNTY SURVEY DEPARTMENT - BILL CARMACK	916-875-7987
U.S.A.	USA NORTH: (811)	800-227-2600

DRAWING INDEX

SHEET NUMBER	DRAWING NUMBER	TITLE
GENERAL		
1	G0	COVER, LOCATION AND VICINITY MAPS
2	G1	ABBREVIATIONS, DESIGNATIONS AND STANDARD SYMBOLS
3	G2	GENRAL NOTES
CIVIL		
4	C1	SITE PLAN
5	C2	PLAN AND PROFILE
ARCHITECT	URAL	
6	A1	ABBREVIATIONS, DESIGNATIONS AND STANDARD SYMBOLS
7	A2	ARCHITECTURAL PLANS
STRUCTURA	NL	
8	S1	STRUCTURAL ABBREVIATIONS, GENERAL STRUCTURAL NOTES
9	S2	SPECIAL INSPECTION AND TEST SCHEDULE
10	S3	STRUCTURAL PLANS
MECHANICA	L	
11	M1	ABBREVIATIONS, STANDARD SYMBOLS AND DESIGNATIONS
12	M2	MECHANICAL PLANS
ELECTRICAL	-	
13	E1	ABBREVIATIONS AND STANDARD SYMBOLS
14	E2	ELECTRICAL PLANS
INSTRUMEN	TATION	
15	I 1	ABBREVIATIONS AND PROCESS AND INSTRUMENTATION SYMBOLS
16	12	PROCESS AND INSTRUMENTATION DIAGRAM


NOTE:

 IN GENERAL, WHERE NEW EQUIPMENT IS SHOWN ON THE SAME SHEET AS EXISTING OR FUTURE EQUIPMENT, THE NEW EQUIPMENT WILL BE SHOWN IN A HEAVIER LINE WEIGHT.








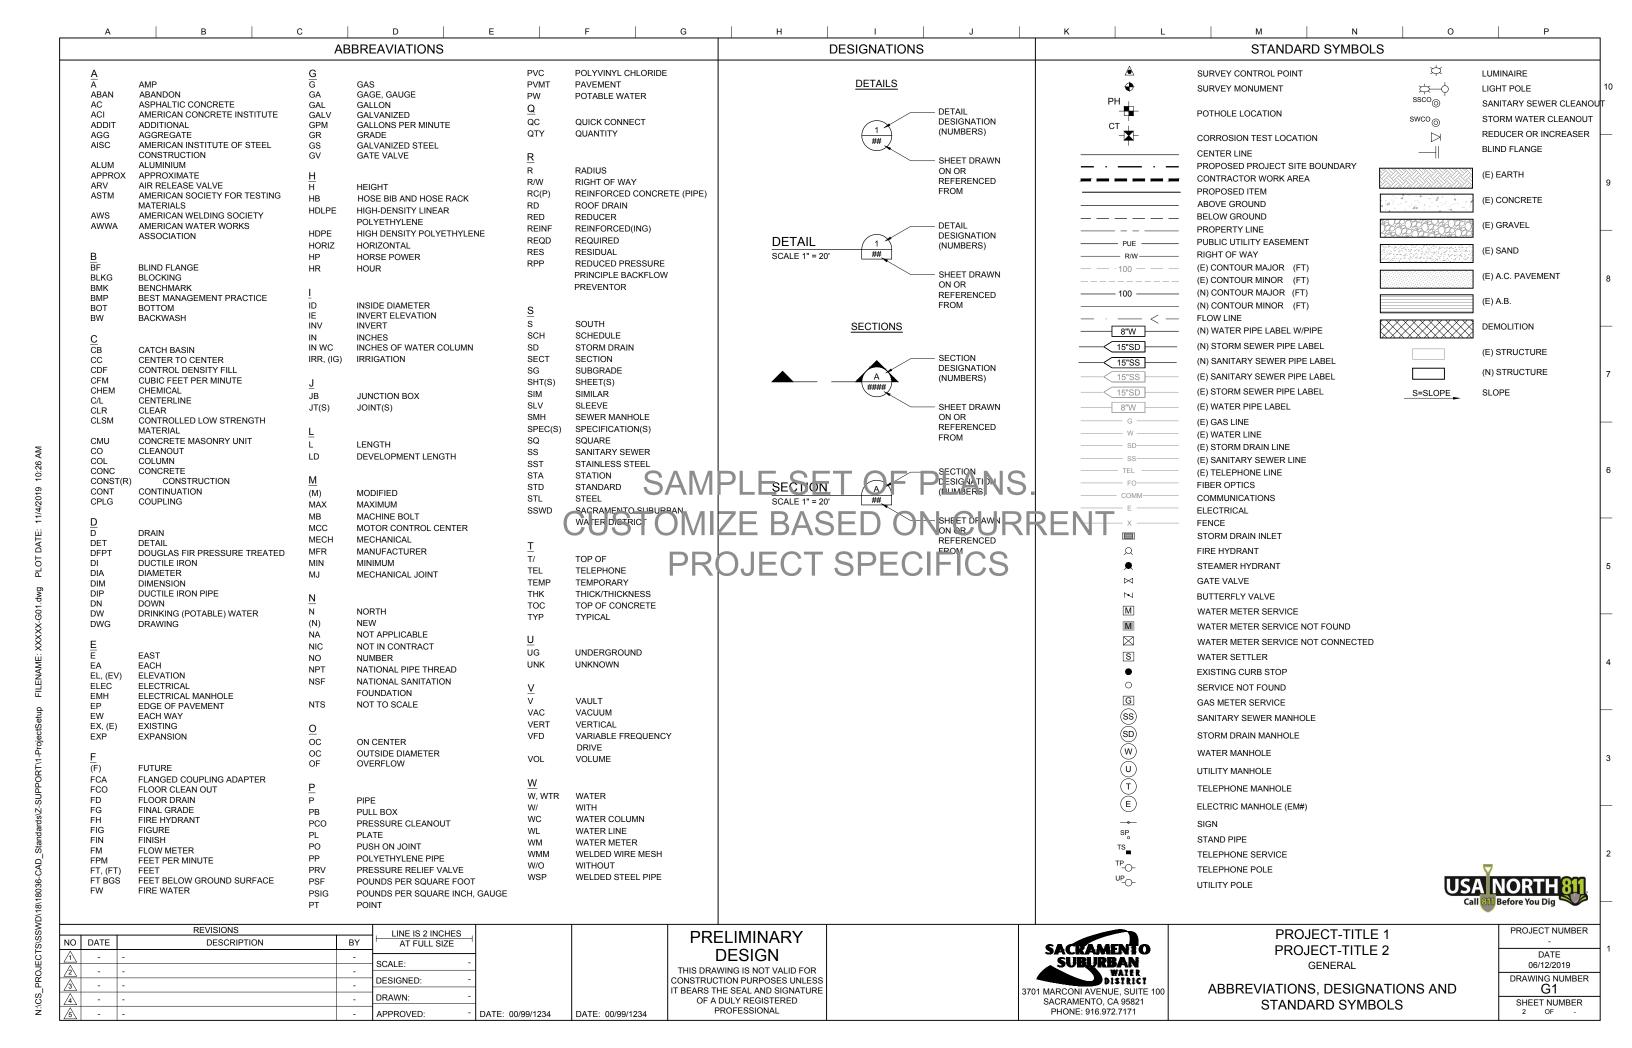

EXAMPLE POINTS



POINT TABLE						
POINT NUMBER	DESCRIPTION	ELEVATION	NORTHING	EASTING		
1	WORK	0.00	190.92	478.49		
2	WORK	0.00	183.93	478.15		

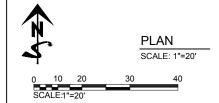

		REVISIONS		. LINE IS 2 INCHES .			
NO	DATE	DESCRIPTION	BY	AT FULL SIZE			PRELIMINARY
<u> 1</u>	-	-	-	SCALE: AS SHOWN			DESIGN
2	-	-	-	OOALL.			THIS DRAWING IS NOT VALID FOR
<u>3</u>	-	-	-	DESIGNED: -			CONSTRUCTION PURPOSES UNLESS IT BEARS THE SEAL AND SIGNATURE
4	-	-	-	DRAWN: -			OF A DULY REGISTERED
<u>/</u> 5	-	-	-	APPROVED: -	DATE: 00/99/1234	DATE: 00/99/1234	PROFESSIONAL



PROJECT-TITLE 1 PROJECT-TITLE 2 CIVIL


SITE PLAN

PROJECT NUMBE
-
DATE
06/12/2019
DRAWING NUMBI
l C1


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3

DRAWING NUMBER C1
SHEET NUMBER
4 OF -

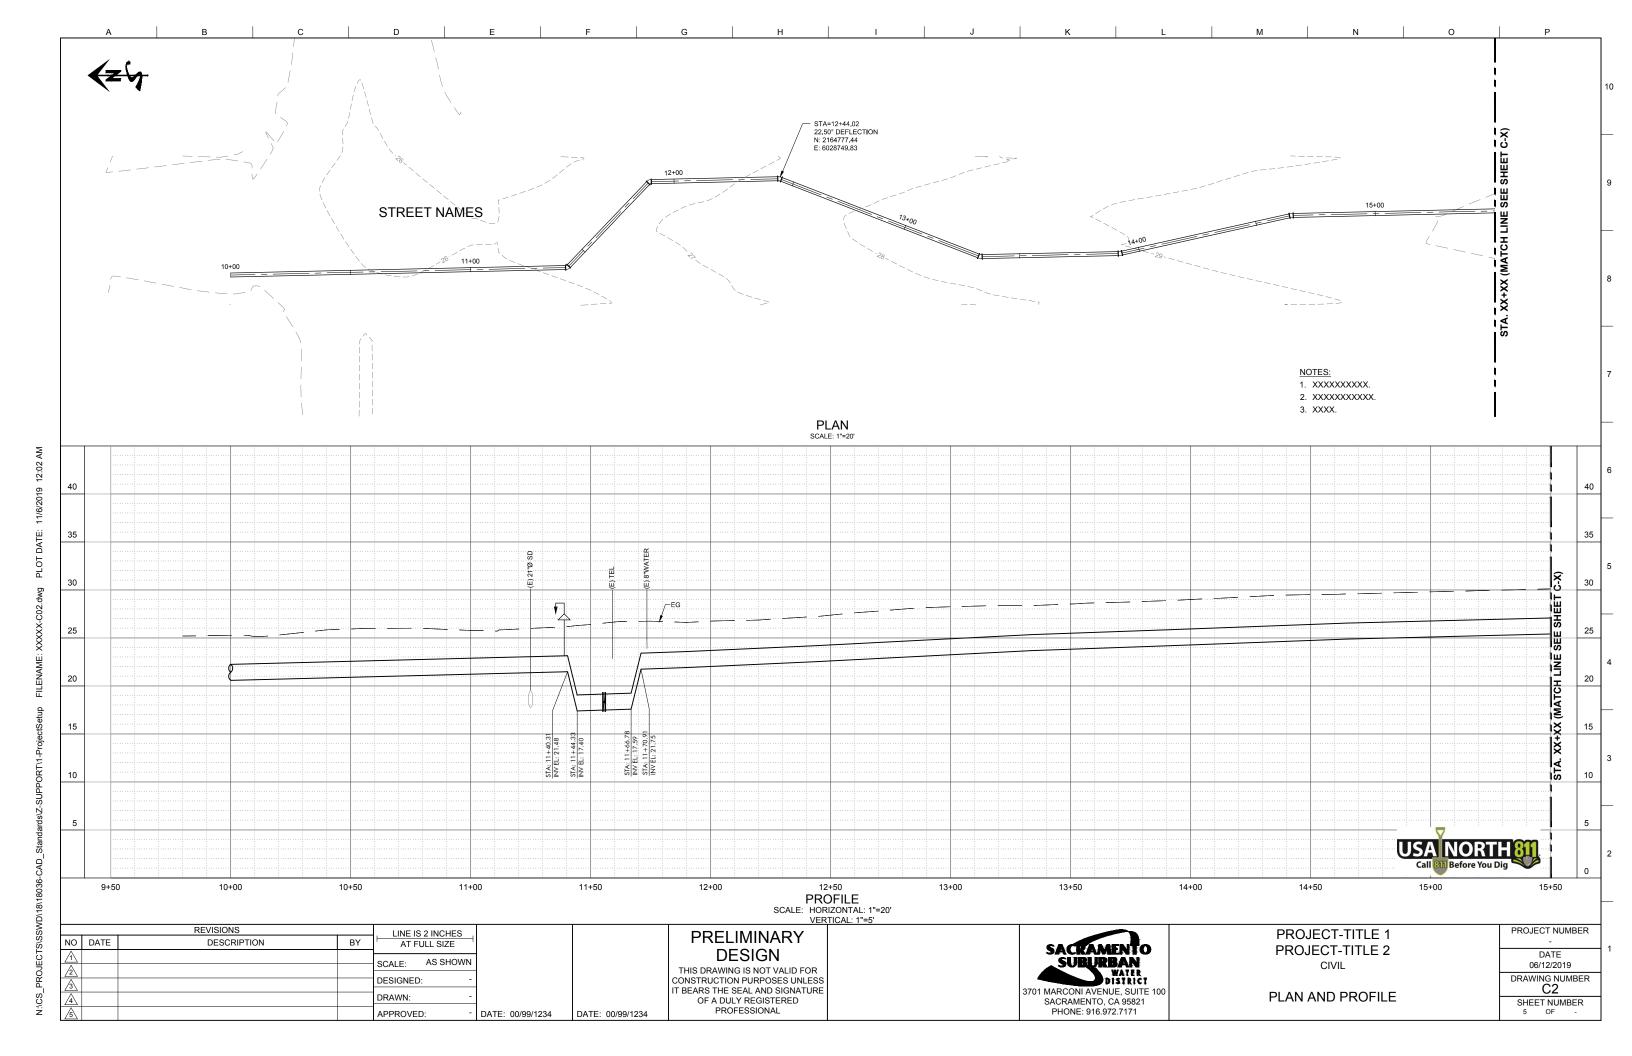

			ABBRE	/IATIONS	3			DESIGN	IATIONS		STANDARD SYMBOLS	
,	ADOVE	DWG D	DRAWING NAIL SIZE	LOA LT	LENGTH OVERALL LIGHT	RFG RM	ROOFING ROOM					
US	ABOVE ACOUSTICAL	D	NAIL SIZE	LF	LIGHT LINEAL FEET	RO	ROUGH OPENING					
L	ADDITIONAL	<u>E</u>		LL	LIVE LOAD	_						
	ADHESIVE	EW	EACH WAY	LVL LVR	LAMINATED VENEER LUMBER LOUVER	<u>S</u>	COLIEDINE					
	ADJUSTABLE ABOVE FINISH FLOOR	EL	EAST ELEVATION	LVIX	LOGVER	SCH SCN	SCHEDULE SCREEN					
	AGGREGATE	ELEV	ELEVATION	M		SECT	SECTION					
	AUTHORITY HAVING JURISDICTION		EQUAL	MFR	MANUFACTURER	SGD	SLIDING GLASS DOOR					
	(BUILDING DEPARTMENT) AIR CONDITIONING	EQP EXCV	EQUIPMENT EXCAVATE	MO MAX	MASONRY OPENING MAXIMUM	SHTH SHT	SHEATHING SHEET					
	ALTERNATE	EXH	EXHAUST	MAS	MASONRY	SH	SHELF, SHELVING					
1	ALUMINUM	EX, (E)	EXISTING	MECH	MECHANIC(AL)	SIM	SIMILAR					
	ANCHOR, ANCHORAGE ANCHOR BOLT	EXT	EXTERIOR	MC MED	MEDICINE CABINET MEDIUM	SKL S	SKYLIGHT SOUTH					
)	ANODIZED	F		MDF	MEDIUM DENSITY FIBERBOARD	SLB	SLAB					
	APPROXIMATE	FOC	FACE OF CONCRETE	MDO	MEDIUM DENSITY OVERLAY	SLD	SLIDER(ING)					
1	APARTMENT ARCHITECT (ARCHITECTURAL)	FOF	FACE OF FINISH	MBR MMB	MEMBER MEMBRANE	SPEC SQ	SPECIFICATION SQUARE					
1	ASPHALT	FOM FOS	FACE OF MASONRY FACE OF STUDS	MTL	METAL	STD	STANDARD					
)	AUTOMATIC	FOW	FACE OF WALL	MWK	MILLWORK	STV	STOVE					
	AVENUE	FBD	FIBERBOARD	MIN	MINIMUM	STL	STEEL					
	AVERAGE AWNING	FCB FGL	FIBER CEMENT BOARD FIBERGLASS	MIR MISC	MIRROR MISCELLANEOUS	STR SA	STRUCTURAL SUPPLY AIR					
	,	FIN	FINISH	MOD	MODULE	SC	SOLID CORE					
_		FFE	FINISHED FLOOR ELEVATION	MLD	MOULDING	SW	SHEAR WALL					
Г	BASEMENT BEAM	FA FE	FIRE ALARM FIRE EXTINGUISHER	MLB	MICRO LAMINATE BEAM	SS SSWD	STAINLESS STEEL SACRAMENTO SUBURBAN WATER					
	BEVELED	FE FPL	FIRE EXTINGUISHER FIREPLACE	N		33441	DISTRICT					
И	BITUMINOUS	FLSH	FLASHING	(N)	NEW	SYS	SYSTEM					
i	BLOCKING	FLR	FLUORESCENT	NOM N	NOMINAL NORTH	т						
	BLOCKING BELOW	FLOR FT	FLUORESCENT FOOT, FEET	N NIC	NOT IN CONTRACT	<u>L</u> TEL	TELEPHONE					
	BOULEVARD	FTG	FOOTING	NTS	NOT TO SCALE	TEMP	TEMPERED					
	BETWEEN	FND	FOUNDATION	NO, #	NUMBER	TK	TIGHT KNOT					
	BOARD BOTTOM	FRM FBO	FRAM(D), (ING) FURNISHED BY OTHERS	0		T&G T/O	TONGUE AND GROOVE TOP OF					
	BUILDING	FUR	FURRED	0	NON-OPERABLE WINDOW	TOC	TOP OF TOP CONCRETE					
	BUILT UP ROOFING				SECTION	TOW	TOP OF WALL					
	BY OTHERS BOTTOM OF	<u>G</u> GA	CACE CALICE	OBS OC	OBSCURE ON CENTER	TB	TOWEL BAR	h = n:				
	BEDROOM	GA GAL	GAGE, GAUGE GALLON	OP	OPAQUE S	L's\/	TUE ULA COTEELS ET	DE PLANS	· ·			
		GL	GLASS, GLAZING	OPG	OPENING	// TYP V	TYPICAL UL	P1 1 L/\110	<i>-</i>			
	CADINET	GI	GALVANIZED IRON	OSB	ORIENTATED STRAND BOARD	O ID -						
;	CABINET CALCULATION	GLBK GLB	GLASS BLOCK GLUE LAMINATED BEAM	OD	OUTSIDE DIAMETER) / (UNI ERWRI ERS ARORATORY		RHML			
	CASEMENT	GT	GROUT	<u>P</u>	0001	UNF	UNFINISHED					
	CATCH BASIN	GRD	GRADE, GRADING	PMT	PAINT(ED)	UNO	UNLESS NOTED OTHERWISE					
	CABINET DOOR CORNER GUARD	GWB	GYPSUM WALL BOARD	PBD PRT	PARTICLE BOARD PARTITION	RR	() IFCT Q	PECIFICS				
	CAST-IN-PLACE (CONCRETE)	Н		PVMT	PAVEMENT	II v/VB II V	VAPOR BARRIER					
	CENTERLINE	HWD	HARDWARE	PERF	PERFORATE(D)	VAR	VARNISH					
ΓR	CLEAN OUT CONTRACT (OR)	HDR	HEATING	PLAS	PLASTER PLASTIC LAMINATE	VIF	VERIFY IN FIELD					
RD	COORDINATE	HTG HVAC	HEATING HEATING, VENTILATION-AIR	PLAM PLT	PLASTIC LAMINATE PLATE	VRN VERT	VENEER VERTICAL					
•	CARPET		CONDITIONING	PLYWD	PLYWOOD	VG	VERTICAL GRAIN					
	CAST-IN-PLACE CAULKING	H	HEIGHT	PCC	PRECAST CONCRETE	VIN	VINYL SHEET					
	CEILING	HC HOR	HOLLOW CORE HORIZONTAL	PCF PLF	POUNDS PER CUBIC FOOT POUNDS PER LINEAR FOOT	W						
	CERAMIC TILE	HB	HOSE BIB	PSF	POUNDS PER SQUARE FOOT	WL	WALL					
	CIRCLE			PSI	POUNDS PER SQUARE INCH	WC	WATER CLOSET					
	CLEAR COLUMN	<u> </u> N	INCH	PBF PRF	PREFABRICATED PREFORMED	WH WP	WATER HEATER WATER PROOFING					
	CONCRETE	INCL	INCH INCLUDE	PT	PRESSURE TREATED	WP WR	WEATHER RESISTANT					
. т	CONCRETE MASONRY UNIT	ID	INSIDE DIAMETER	PL	PROPERTY LINE	WRB	WEATHER RESISTIVE BARRIER					
T -	CONSTRUCTION CONTINUOUS	INS	INSULATE	PH	TOILET PAPER HANGER	WWF	WELDED WIRE FABRIC					
	CONTROL JOINT	INT INV	INTERIOR INVERT	Q		WWM W	WELDED WIRE MESH WEST					
?	CORRUGATED			QTY	QUANTITY	WIN	WINDOW					
ı	CUBIC FOOT CUBIC YARD	<u>J</u>		QT	QUARRY TILE	W/O	WITHOUT					
	CODIC IAIO	JNT	JOINT	R		W/ WD	WITH WOOD					
		JST	JOIST	<u>K</u> RAD	RADIUS	VVU	***************************************					
	DAMP PROOFING	K		REF	REFERENCE	<u>X</u>						
	DETAIL DIAMETER	KD	KILN DRIED	RFL	REFLECT(ED),(IVE),(OR)	\overline{X}	OPERABLE WINDOW SECTION					
	DIMENSION	KIT	KITCHEN	REFR REG	REF REGISTER							
	DISHWASHER	L		RE	REINFORCED							
	DIVISION DOOR	LB	POUND	REQ'D	REQUIRED							
	DOUBLE HUNG	LAM	LAMINATE(D)	RA REV	RETURN AIR REVISION							
	DOWNSPOUT	LAV LH	LAVATORY LEFT HAND	R	RISER							
₹	DRAWER DRAIN TILE	L.	LENGTH	RD	ROD							
				R&S	ROD AND SHELF							
	REVISIONS		LINE IS 2 INCHES	3		PF	RELIMINARY			PRO	JECT-TITLE 1	PROJEC1
ATE	DESCRIPTION		BY AT FULL SIZE			''	DESIGN		SACRAMENTO	1	JECT-TITLE 2	DA
-	-		SCALE: AS SHO	ΝN					SUBURBAN		CHITECTURAL	06/12
-	-		DESIGNED:	_			RAWING IS NOT VALID FOR UCTION PURPOSES UNLESS		WATER			DRAWING
-	-		-	\dashv			S THE SEAL AND SIGNATURE		3701 MARCONI AVENUE, SUITE 100	ABBREVIATION	NS, DESIGNATIONS AND	
	I .		_ DRAWN:	- 1								
-	-		- DRAWN.			OF	A DULY REGISTERED PROFESSIONAL		SACRAMENTO, CA 95821 PHONE: 916.972.7171		DARD SYMBOLS	SHEET 5

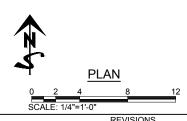

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PRELIMINARY DESIGN

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DATE: 00/99/1234



PROJECT-TITLE 1
PROJECT-TITLE 2
ARCHITECTURAL

ARCHITECTURAL PLANS

PROJECT NUMBE
-
DATE
06/12/2019
DRAWING NUMBE
1 1

DRAWING NUMBER
A2
SHEET NUMBER
6 OF -

OF A DULY REGISTERED

APPROVED

DATE: 00/99/1234

DATE: 00/99/1234

SACRAMENTO, CA 95821

PHONE: 916 972 7171


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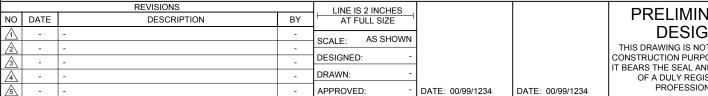
STRUCTURAL NOTES

APPROVED:

DATE: 00/99/1234

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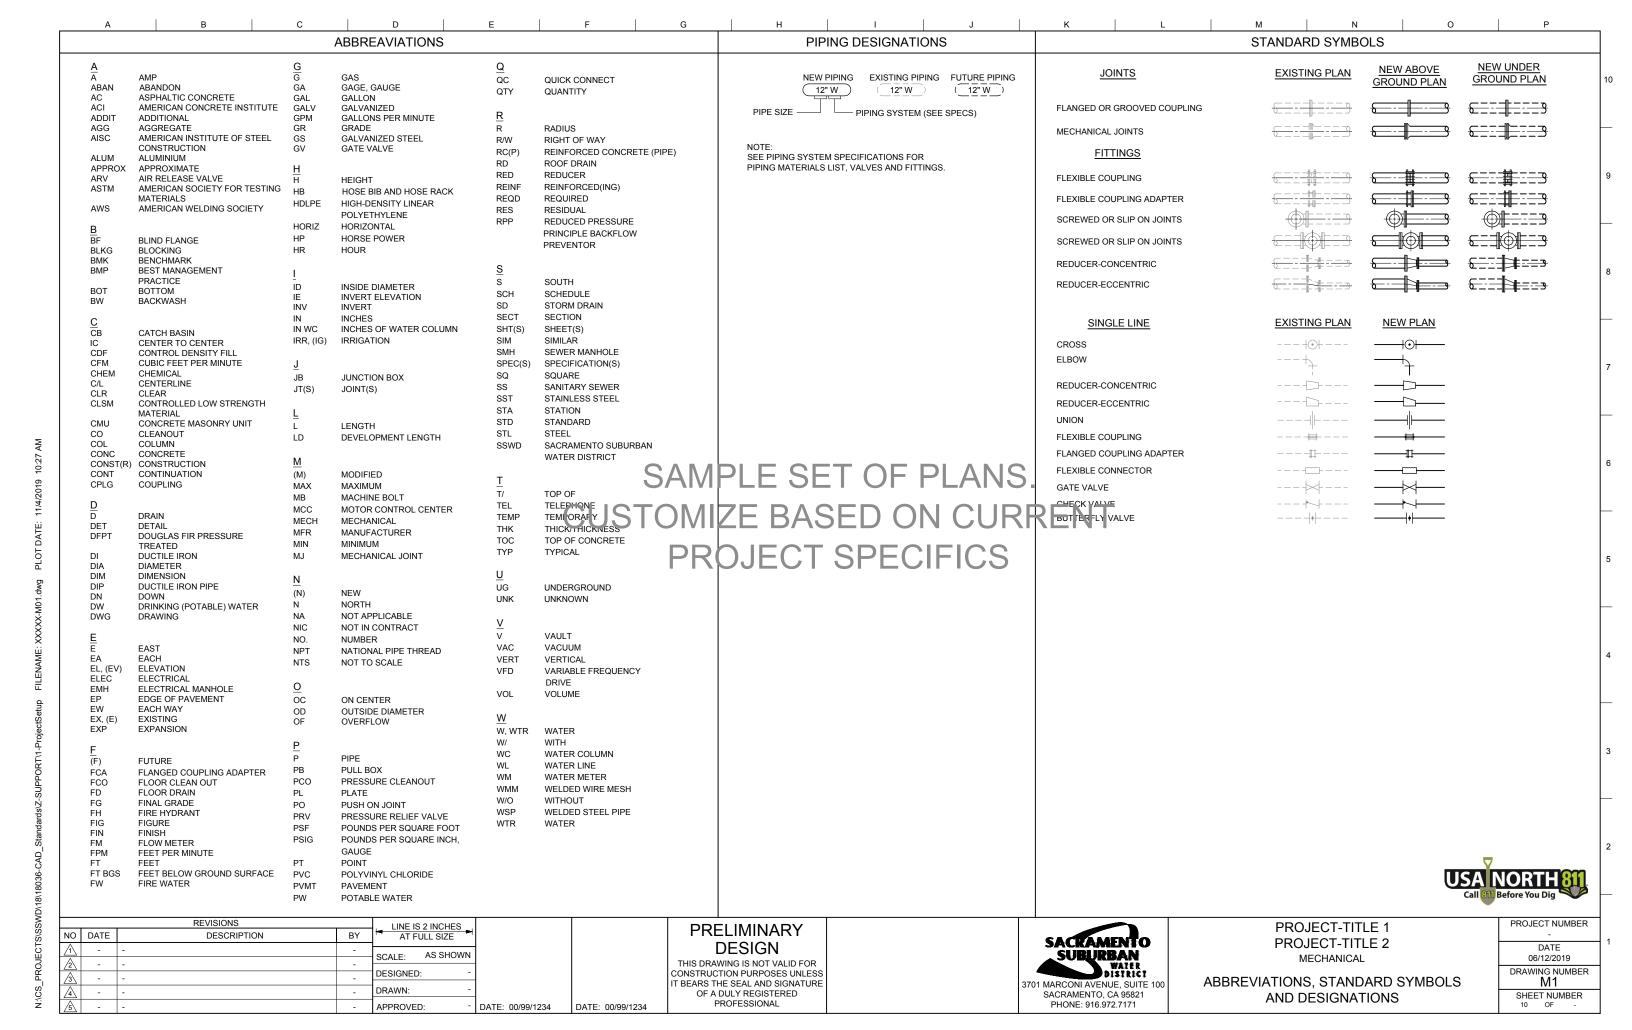
PROJECT-TITLE 1 PROJECT-TITLE 2 STRUCTURAL


STRUCTURAL PLANS
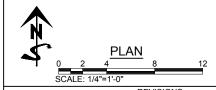
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DATE
06/12/2019

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PRELIMINARY DESIGN

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DATE: 00/99/1234

SACRAMENTO SUBURBAN WATER DISTRICT
3701 MARCONI AVENUE, SUITE 100
SACRAMENTO, CA 95821
PHONE: 916.972.7171

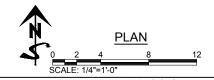PROJECT-TITLE 1
PROJECT-TITLE 2
MECHANICAL

MECHANICAL PLANS

PROJECT NUMB
-
DATE
06/12/2019

DRAWING NUMBER M2

SHEET NUMBER
11 OF -

IT BEARS THE SEAL AND SIGNATURE

OF A DULY REGISTERED

DRAWN:

APPROVED:

DATE: 00/99/1234

DATE: 00/99/1234

ABBREVIATIONS AND STANDARD

SYMBOLS


3701 MARCONI AVENUE, SUITE 100

SACRAMENTO, CA 95821

PHONE: 916.972.7171

E1

SHEET NUMBER

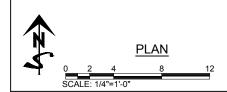





PROJECT-TITLE 1
PROJECT-TITLE 2
ELECTRICAL

ELECTRICAL PLANS

PROJECT NUMBER
-
DATE
06/12/2019
DRAWING NUMBER
E2
SHEET NUMBER
13 OF -

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<u>\$</u>	-	-	-	APPROVED: -	DATE: 00/99/1234	DATE: 00/99/1234	PROFESSIONAL

USANORTH BEFORE YOU DIG

VALVE OPERATORS P PNEUMATIC OPERATOR OPERATOR PRESSURE BALANCED M MOTOR SV SOLENOID VALVE

EQUIPMENT DESCRIPTION

XXXYYY

XXX = MECHANICAL EQUIPMEN'
DESIGNATION
YYY = MECHANICAL
EQUIPMENT NUMBER
X-YYY

X = PIPING SIZE INCHES
YYY = PROCESS MATERIAL

INPUT & OUTPUT SIGNALS TO PLC/RTU ANALOG OUTPUT INPUT PULSE INPUT DIGITAL OUTPUT DIGITAL OUTPUT

	P&ID I	NSTRUMENT	IDENTIFICAT	TION		
	FIRST LETTER	R (S)	SUCCEEDING LETTER(S)			
CODE LETTER	MEASURED OR INITIATING VARIABLE	MODIFIER	READOUT OR PASSIVE FUNCTION	OUTPUT FUNCTION	MODIFIER	
Α	ANALYSIS		ALARM			
В	BURNER FLAME					
С	CONDUCTIVITY			CONTROL	CLOSE	
D	DENSITY	DIFFERENTIAL				
E	VOLTAGE		ELEMENT			
F	FLOWRATE	RATIO				
G	GAUGING		GLASS			
Н	HAND				HIGH	
I	CURRENT		INDICATE			
J	POWER	SCAN				
K	TIME			CONTROL STATION		
L	LEVEL		LIGHT		LOW	
М	MOISTURE	MOMENTARY			MIDDLE	
N	STATUS					
0	OPERATOR		ORIFICE		OPEN	
Р	PRESSURE		POINT			
Q	EVENT	TOTALIZE				
R	RESET		RECORD			
S	SPEED	SAFETY		SWITCH		
Т	TEMPERATURE			TRANSMIT		
U	MULTIVARIABLE		MULTIFUNCTION			
V	VIBRATION			VALVE		
W	WEIGHT		WELL			
Х	STATUS		TROUBLE/FAIL			
Υ	MONITOR/CONTROL			COMPUTE/RELAY		
Z	POSITION			ACTUATE		

SAMPLE SET OF PLANS. Z

CUSTOMIZE BASED ON CURRENT

PROJECT SPECIFICS

GENERAL INSTRUMENT OR FUNCTION SYMBOLS					
	LOCATION NORMALLY ACCESSIBLE TO OPERATOR	FIELD MOUNTED	LOCATION NORMALLY NOT ACCESSIBLE TO OPERATOR	SECONDARY LOCATION NORMALLY ACCESSIBLE TO OPERATOR	SECONDARY LOCATION NORMALLY NOT ACCESSIBLE TO OPERATOR
DISCRETE INSTRUMENTS	$\begin{pmatrix} x \\ x \end{pmatrix}$	X	$\left(\frac{X}{X}\right)$		$\left(\frac{\overline{x}}{\overline{x}}\right)$
SHARED DISPLAY SHARED CONTROL	XX	X	$\left(\frac{x}{x}\right)$		$\frac{\overline{x}}{\overline{x}}$
COMPUTER FUNCTION	$\left\langle \begin{array}{c} X \\ X \end{array} \right\rangle$	XX	$\left\langle \frac{x}{x} \right\rangle$		$\left\langle \frac{\overline{x}}{\overline{x}} \right\rangle$
PROGRAMMABLE LOGIC CONTROL	XX	XX	X X		X X

		REVISIONS	LINE IS 2 INCHES	
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2	-	-	-	OOALL.
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4	-	-	-	DRAWN: -
<u>/</u> 5	-	-	-	APPROVED: - DATE: 00/99/1234

PRELIMINARY DESIGN

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DATE: 00/99/1234



PROJECT-TITLE 1
PROJECT-TITLE 2
INSTRUMENTATION

ABBREVIATIONS AND PROCESS AND INSTRUMENTATION SYMBOLS

PROJECT NUMBER
-
DATE
06/12/2019
DRAWING NUMBER
l I1

SHEET NUMBER

JOECT SOSOWOTO TOOGS-CAU_Statements - STATEMENT STATEMENT - AAAAA TOT DATE: 11420 B 10.20 AW